

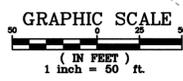
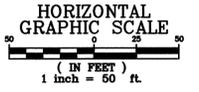
**NOTES:**  
 1. FIELD CONFIRM ALL DIMENSIONS AND CONDITIONS BEFORE BEGINNING WORK.

MATCHLINE STA. 22+00 1/C-201

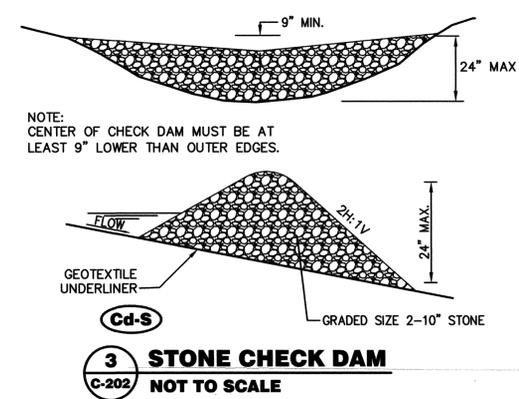
MATCHLINE STA. 22+00 2/C-201

**1 SANITARY PLAN STA. 22+00 TO 29+50**  
 SCALE: 1"=50'

**2 SANITARY PROFILE STA. 22+00 TO 29+50**  
 SCALE: 1"=50' HORIZ.  
 1"=10' VERT.



- 3 TEMPORARY SEEDING**  
(TYP. ALL DISTURBED AREAS)
- 4 PERMANENT SEEDING**  
(TYP. ALL DISTURBED AREAS)



NOTE:  
 CENTER OF CHECK DAM MUST BE AT  
 LEAST 9" LOWER THAN OUTER EDGES.

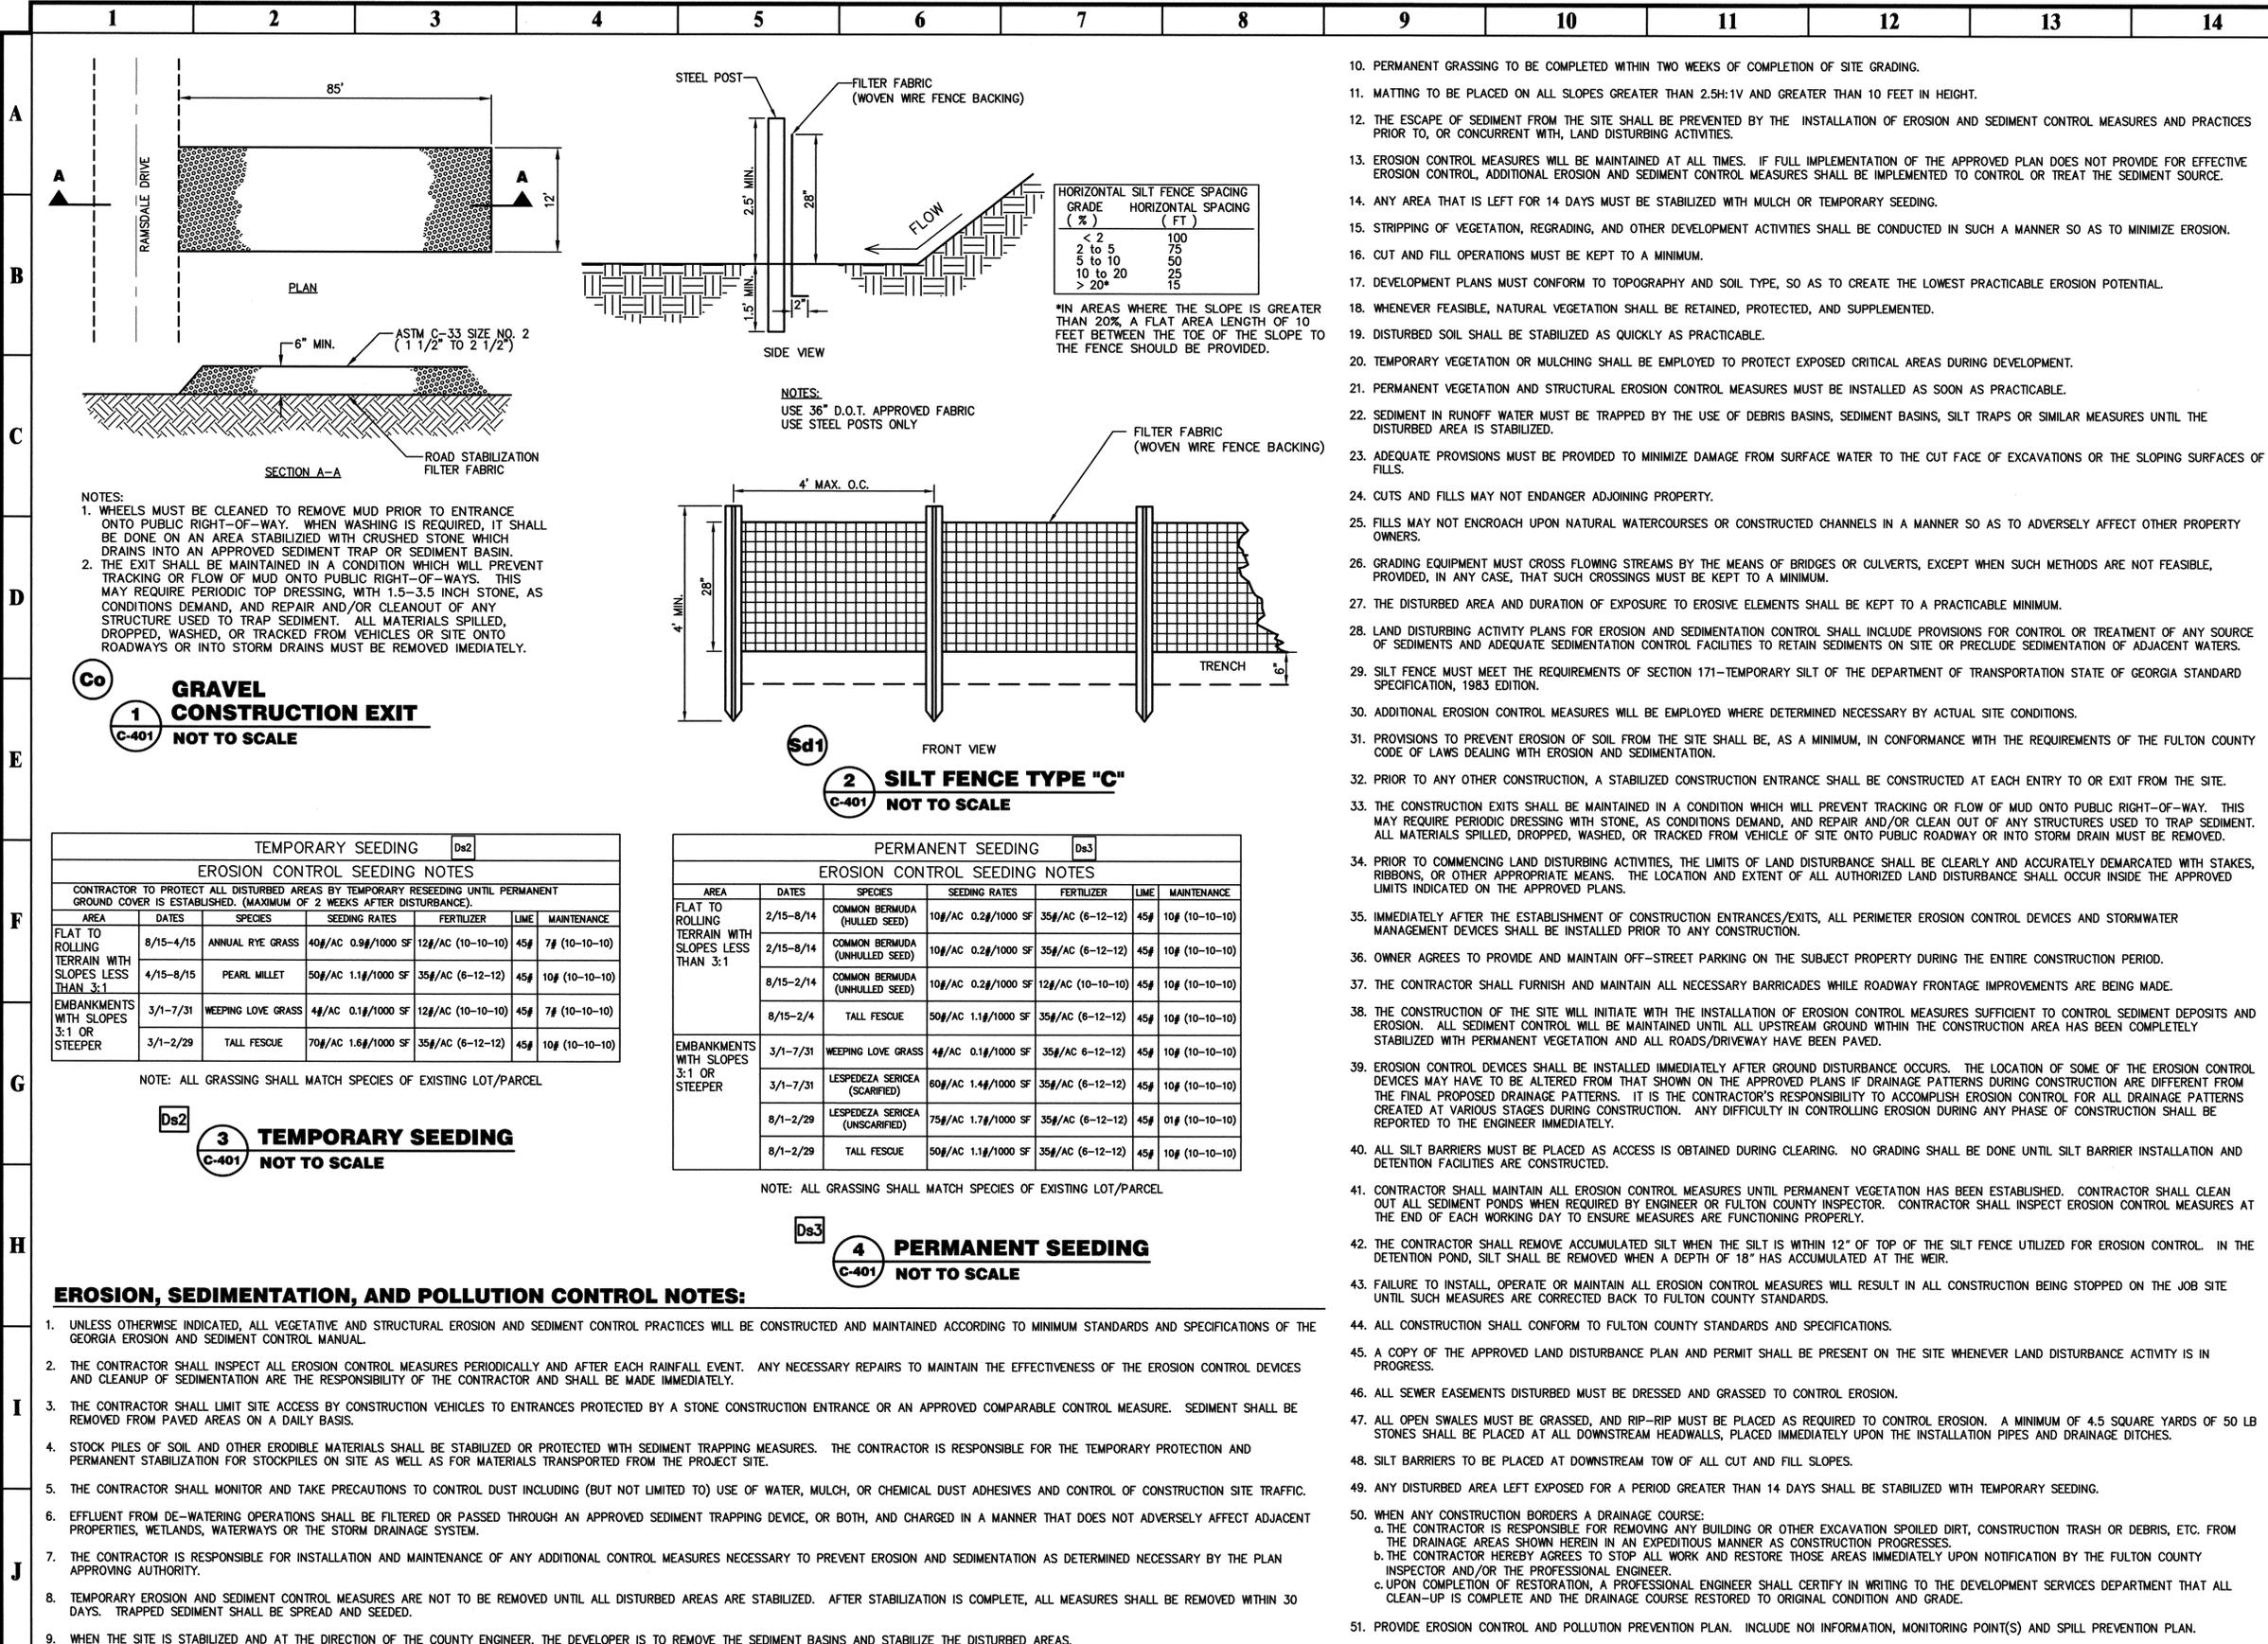
**3 STONE CHECK DAM**  
 NOT TO SCALE



IF YOU DIG GEORGIA...  
 CALL US FIRST!  
 UTILITIES PROTECTION CENTER  
 1-800-282-7411  
 (404) 325-5000  
 (metro Atlanta only)  
 IT'S THE LAW

<b>PRIME ENGINEERING</b> INCORPORATED		1888 EMERY STREET N.W., SUITE 300 ATLANTA, GEORGIA 30318 404-425-7100	
PROJECT: <b>MID BROADWELL PETITION SEWER</b>		PREPARED FOR: <b>FULTON COUNTY DEPARTMENT OF PUBLIC WORKS</b>	
REVISIONS	NO.	DATE	DESCRIPTION
	0	03/07/07	CONSTRUCTION DOCUMENTS
SEAL			
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DRAWING TITLE <b>SANITARY PLAN &amp; PROFILE STA. 22+00 TO STA. 29+50</b>			
DRAWING DATE	DRAWN BY	DESIGNED BY	CHECKED BY
03/07/2007	JLS	AJS	RRM
DRAWING SCALE	AS SHOWN	PROJECT NUMBER	DRAWING NUMBER
		06-2015-009	<b>C-202</b>
NOT ISSUED FOR CONSTRUCTION			

R:\2015-009 Mid Broadwell Petition Sewer.dwg [2015-03-07 07:41:17 PM]



**1 GRAVEL CONSTRUCTION EXIT**  
C-401 NOT TO SCALE

**2 SILT FENCE TYPE 'C'**  
C-401 NOT TO SCALE

**3 TEMPORARY SEEDING**  
C-401 NOT TO SCALE

**4 PERMANENT SEEDING**  
C-401 NOT TO SCALE

TEMPORARY SEEDING Ds2						
EROSION CONTROL SEEDING NOTES						
CONTRACTOR TO PROTECT ALL DISTURBED AREAS BY TEMPORARY RESEEDING UNTIL PERMANENT GROUND COVER IS ESTABLISHED. (MAXIMUM OF 2 WEEKS AFTER DISTURBANCE).						
AREA	DATES	SPECIES	SEEDING RATES	FERTILIZER	LIME	MAINTENANCE
FLAT TO ROLLING TERRAIN WITH SLOPES LESS THAN 3:1	8/15-4/15	ANNUAL RYE GRASS	40#/AC 0.9#/1000 SF	12#/AC (10-10-10)	45#	7# (10-10-10)
	4/15-8/15	PEARL MILLET	50#/AC 1.1#/1000 SF	35#/AC (6-12-12)	45#	10# (10-10-10)
EMBANKMENTS WITH SLOPES 3:1 OR STEEPER	3/1-7/31	WEEPING LOVE GRASS	4#/AC 0.1#/1000 SF	12#/AC (10-10-10)	45#	7# (10-10-10)
	3/1-2/29	TALL FESCUE	70#/AC 1.6#/1000 SF	35#/AC (6-12-12)	45#	10# (10-10-10)

PERMANENT SEEDING Ds3						
EROSION CONTROL SEEDING NOTES						
AREA	DATES	SPECIES	SEEDING RATES	FERTILIZER	LIME	MAINTENANCE
FLAT TO ROLLING TERRAIN WITH SLOPES LESS THAN 3:1	2/15-8/14	COMMON BERMUDA (HULLED SEED)	10#/AC 0.2#/1000 SF	35#/AC (6-12-12)	45#	10# (10-10-10)
	2/15-8/14	COMMON BERMUDA (UNHULLED SEED)	10#/AC 0.2#/1000 SF	35#/AC (6-12-12)	45#	10# (10-10-10)
	8/15-2/14	COMMON BERMUDA (UNHULLED SEED)	10#/AC 0.2#/1000 SF	12#/AC (10-10-10)	45#	10# (10-10-10)
	8/15-2/4	TALL FESCUE	50#/AC 1.1#/1000 SF	35#/AC (6-12-12)	45#	10# (10-10-10)
EMBANKMENTS WITH SLOPES 3:1 OR STEEPER	3/1-7/31	WEEPING LOVE GRASS	4#/AC 0.1#/1000 SF	35#/AC 6-12-12)	45#	10# (10-10-10)
	3/1-7/31	LESPEDEZA SERICEA (SCARIFIED)	60#/AC 1.4#/1000 SF	35#/AC (6-12-12)	45#	10# (10-10-10)
	8/1-2/29	LESPEDEZA SERICEA (UNSCARIFIED)	75#/AC 1.7#/1000 SF	35#/AC (6-12-12)	45#	01# (10-10-10)
	8/1-2/29	TALL FESCUE	50#/AC 1.1#/1000 SF	35#/AC (6-12-12)	45#	10# (10-10-10)

**EROSION, SEDIMENTATION, AND POLLUTION CONTROL NOTES:**

- UNLESS OTHERWISE INDICATED, ALL VEGETATIVE AND STRUCTURAL EROSION AND SEDIMENT CONTROL PRACTICES WILL BE CONSTRUCTED AND MAINTAINED ACCORDING TO MINIMUM STANDARDS AND SPECIFICATIONS OF THE GEORGIA EROSION AND SEDIMENT CONTROL MANUAL.
- THE CONTRACTOR SHALL INSPECT ALL EROSION CONTROL MEASURES PERIODICALLY AND AFTER EACH RAINFALL EVENT. ANY NECESSARY REPAIRS TO MAINTAIN THE EFFECTIVENESS OF THE EROSION CONTROL DEVICES AND CLEANUP OF SEDIMENTATION ARE THE RESPONSIBILITY OF THE CONTRACTOR AND SHALL BE MADE IMMEDIATELY.
- THE CONTRACTOR SHALL LIMIT SITE ACCESS BY CONSTRUCTION VEHICLES TO ENTRANCES PROTECTED BY A STONE CONSTRUCTION ENTRANCE OR AN APPROVED COMPARABLE CONTROL MEASURE. SEDIMENT SHALL BE REMOVED FROM PAVED AREAS ON A DAILY BASIS.
- STOCK PILES OF SOIL AND OTHER ERODIBLE MATERIALS SHALL BE STABILIZED OR PROTECTED WITH SEDIMENT TRAPPING MEASURES. THE CONTRACTOR IS RESPONSIBLE FOR THE TEMPORARY PROTECTION AND PERMANENT STABILIZATION FOR STOCKPILES ON SITE AS WELL AS FOR MATERIALS TRANSPORTED FROM THE PROJECT SITE.
- THE CONTRACTOR SHALL MONITOR AND TAKE PRECAUTIONS TO CONTROL DUST INCLUDING (BUT NOT LIMITED TO) USE OF WATER, MULCH, OR CHEMICAL DUST ADHESIVES AND CONTROL OF CONSTRUCTION SITE TRAFFIC.
- EFFLUENT FROM DE-WATERING OPERATIONS SHALL BE FILTERED OR PASSED THROUGH AN APPROVED SEDIMENT TRAPPING DEVICE, OR BOTH, AND CHARGED IN A MANNER THAT DOES NOT ADVERSELY AFFECT ADJACENT PROPERTIES, WETLANDS, WATERWAYS OR THE STORM DRAINAGE SYSTEM.
- THE CONTRACTOR IS RESPONSIBLE FOR INSTALLATION AND MAINTENANCE OF ANY ADDITIONAL CONTROL MEASURES NECESSARY TO PREVENT EROSION AND SEDIMENTATION AS DETERMINED NECESSARY BY THE PLAN APPROVING AUTHORITY.
- TEMPORARY EROSION AND SEDIMENT CONTROL MEASURES ARE NOT TO BE REMOVED UNTIL ALL DISTURBED AREAS ARE STABILIZED. AFTER STABILIZATION IS COMPLETE, ALL MEASURES SHALL BE REMOVED WITHIN 30 DAYS. TRAPPED SEDIMENT SHALL BE SPREAD AND SEEDDED.
- WHEN THE SITE IS STABILIZED AND AT THE DIRECTION OF THE COUNTY ENGINEER, THE DEVELOPER IS TO REMOVE THE SEDIMENT BASINS AND STABILIZE THE DISTURBED AREAS.

- PERMANENT GRASSING TO BE COMPLETED WITHIN TWO WEEKS OF COMPLETION OF SITE GRADING.
- MATting TO BE PLACED ON ALL SLOPES GREATER THAN 2.5H:1V AND GREATER THAN 10 FEET IN HEIGHT.
- THE ESCAPE OF SEDIMENT FROM THE SITE SHALL BE PREVENTED BY THE INSTALLATION OF EROSION AND SEDIMENT CONTROL MEASURES AND PRACTICES PRIOR TO, OR CONCURRENT WITH, LAND DISTURBING ACTIVITIES.
- EROSION CONTROL MEASURES WILL BE MAINTAINED AT ALL TIMES. IF FULL IMPLEMENTATION OF THE APPROVED PLAN DOES NOT PROVIDE FOR EFFECTIVE EROSION CONTROL, ADDITIONAL EROSION AND SEDIMENT CONTROL MEASURES SHALL BE IMPLEMENTED TO CONTROL OR TREAT THE SEDIMENT SOURCE.
- ANY AREA THAT IS LEFT FOR 14 DAYS MUST BE STABILIZED WITH MULCH OR TEMPORARY SEEDING.
- STRIPPING OF VEGETATION, REGRADING, AND OTHER DEVELOPMENT ACTIVITIES SHALL BE CONDUCTED IN SUCH A MANNER SO AS TO MINIMIZE EROSION.
- CUT AND FILL OPERATIONS MUST BE KEPT TO A MINIMUM.
- DEVELOPMENT PLANS MUST CONFORM TO TOPOGRAPHY AND SOIL TYPE, SO AS TO CREATE THE LOWEST PRACTICABLE EROSION POTENTIAL.
- WHENEVER FEASIBLE, NATURAL VEGETATION SHALL BE RETAINED, PROTECTED, AND SUPPLEMENTED.
- DISTURBED SOIL SHALL BE STABILIZED AS QUICKLY AS PRACTICABLE.
- TEMPORARY VEGETATION OR MULCHING SHALL BE EMPLOYED TO PROTECT EXPOSED CRITICAL AREAS DURING DEVELOPMENT.
- PERMANENT VEGETATION AND STRUCTURAL EROSION CONTROL MEASURES MUST BE INSTALLED AS SOON AS PRACTICABLE.
- SEDIMENT IN RUNOFF WATER MUST BE TRAPPED BY THE USE OF DEBRIS BASINS, SEDIMENT BASINS, SILT TRAPS OR SIMILAR MEASURES UNTIL THE DISTURBED AREA IS STABILIZED.
- ADEQUATE PROVISIONS MUST BE PROVIDED TO MINIMIZE DAMAGE FROM SURFACE WATER TO THE CUT FACE OF EXCAVATIONS OR THE SLOPING SURFACES OF FILLS.
- CUTS AND FILLS MAY NOT ENDANGER ADJOINING PROPERTY.
- FILLS MAY NOT ENCRoACH UPON NATURAL WATERCOURSES OR CONSTRUCTED CHANNELS IN A MANNER SO AS TO ADVERSELY AFFECT OTHER PROPERTY OWNERS.
- GRADING EQUIPMENT MUST CROSS FLOWING STREAMS BY THE MEANS OF BRIDGES OR CULVERTS, EXCEPT WHEN SUCH METHODS ARE NOT FEASIBLE, PROVIDED, IN ANY CASE, THAT SUCH CROSSINGS MUST BE KEPT TO A MINIMUM.
- THE DISTURBED AREA AND DURATION OF EXPOSURE TO EROSION ELEMENTS SHALL BE KEPT TO A PRACTICABLE MINIMUM.
- LAND DISTURBING ACTIVITY PLANS FOR EROSION AND SEDIMENTATION CONTROL SHALL INCLUDE PROVISIONS FOR CONTROL OR TREATMENT OF ANY SOURCE OF SEDIMENTS AND ADEQUATE SEDIMENTATION CONTROL FACILITIES TO RETAIN SEDIMENTS ON SITE OR PRECLUDE SEDIMENTATION OF ADJACENT WATERS.
- SILT FENCE MUST MEET THE REQUIREMENTS OF SECTION 171-TEMPORARY SILT OF THE DEPARTMENT OF TRANSPORTATION STATE OF GEORGIA STANDARD SPECIFICATION, 1983 EDITION.
- ADDITIONAL EROSION CONTROL MEASURES WILL BE EMPLOYED WHERE DETERMINED NECESSARY BY ACTUAL SITE CONDITIONS.
- PROVISIONS TO PREVENT EROSION OF SOIL FROM THE SITE SHALL BE, AS A MINIMUM, IN CONFORMANCE WITH THE REQUIREMENTS OF THE FULTON COUNTY CODE OF LAWS DEALING WITH EROSION AND SEDIMENTATION.
- PRIOR TO ANY OTHER CONSTRUCTION, A STABILIZED CONSTRUCTION ENTRANCE SHALL BE CONSTRUCTED AT EACH ENTRY TO OR EXIT FROM THE SITE.
- THE CONSTRUCTION EXITS SHALL BE MAINTAINED IN A CONDITION WHICH WILL PREVENT TRACKING OR FLOW OF MUD ONTO PUBLIC RIGHT-OF-WAY. THIS MAY REQUIRE PERIODIC DRESSING WITH STONE, AS CONDITIONS DEMAND, AND REPAIR AND/OR CLEAN OUT OF ANY STRUCTURES USED TO TRAP SEDIMENT. ALL MATERIALS SPILLED, DROPPED, WASHED, OR TRACKED FROM VEHICLE OF SITE ONTO PUBLIC ROADWAY OR INTO STORM DRAIN MUST BE REMOVED.
- PRIOR TO COMMENCING LAND DISTURBING ACTIVITIES, THE LIMITS OF LAND DISTURBANCE SHALL BE CLEARLY AND ACCURATELY DEMARCATED WITH STAKES, RIBBONS, OR OTHER APPROPRIATE MEANS. THE LOCATION AND EXTENT OF ALL AUTHORIZED LAND DISTURBANCE SHALL OCCUR INSIDE THE APPROVED LIMITS INDICATED ON THE APPROVED PLANS.
- IMMEDIATELY AFTER THE ESTABLISHMENT OF CONSTRUCTION ENTRANCES/EXITS, ALL PERIMETER EROSION CONTROL DEVICES AND STORMWATER MANAGEMENT DEVICES SHALL BE INSTALLED PRIOR TO ANY CONSTRUCTION.
- OWNER AGREES TO PROVIDE AND MAINTAIN OFF-STREET PARKING ON THE SUBJECT PROPERTY DURING THE ENTIRE CONSTRUCTION PERIOD.
- THE CONTRACTOR SHALL FURNISH AND MAINTAIN ALL NECESSARY BARRICADES WHILE ROADWAY FRONTAGE IMPROVEMENTS ARE BEING MADE.
- THE CONSTRUCTION OF THE SITE WILL INITIATE WITH THE INSTALLATION OF EROSION CONTROL MEASURES SUFFICIENT TO CONTROL SEDIMENT DEPOSITS AND EROSION. ALL SEDIMENT CONTROL WILL BE MAINTAINED UNTIL ALL UPSTREAM GROUND WITHIN THE CONSTRUCTION AREA HAS BEEN COMPLETELY STABILIZED WITH PERMANENT VEGETATION AND ALL ROADS/DRIVEWAY HAVE BEEN PAVED.
- EROSION CONTROL DEVICES SHALL BE INSTALLED IMMEDIATELY AFTER GROUND DISTURBANCE OCCURS. THE LOCATION OF SOME OF THE EROSION CONTROL DEVICES MAY HAVE TO BE ALTERED FROM THAT SHOWN ON THE APPROVED PLANS IF DRAINAGE PATTERNS DURING CONSTRUCTION ARE DIFFERENT FROM THE FINAL PROPOSED DRAINAGE PATTERNS. IT IS THE CONTRACTOR'S RESPONSIBILITY TO ACCOMPLISH EROSION CONTROL FOR ALL DRAINAGE PATTERNS CREATED AT VARIOUS STAGES DURING CONSTRUCTION. ANY DIFFICULTY IN CONTROLLING EROSION DURING ANY PHASE OF CONSTRUCTION SHALL BE REPORTED TO THE ENGINEER IMMEDIATELY.
- ALL SILT BARRIERS MUST BE PLACED AS ACCESS IS OBTAINED DURING CLEARING. NO GRADING SHALL BE DONE UNTIL SILT BARRIER INSTALLATION AND DETENTION FACILITIES ARE CONSTRUCTED.
- CONTRACTOR SHALL MAINTAIN ALL EROSION CONTROL MEASURES UNTIL PERMANENT VEGETATION HAS BEEN ESTABLISHED. CONTRACTOR SHALL CLEAN OUT ALL SEDIMENT PONDS WHEN REQUIRED BY ENGINEER OR FULTON COUNTY INSPECTOR. CONTRACTOR SHALL INSPECT EROSION CONTROL MEASURES AT THE END OF EACH WORKING DAY TO ENSURE MEASURES ARE FUNCTIONING PROPERLY.
- THE CONTRACTOR SHALL REMOVE ACCUMULATED SILT WHEN THE SILT IS WITHIN 12" OF TOP OF THE SILT FENCE UTILIZED FOR EROSION CONTROL. IN THE DETENTION POND, SILT SHALL BE REMOVED WHEN A DEPTH OF 18" HAS ACCUMULATED AT THE WEIR.
- FAILURE TO INSTALL, OPERATE OR MAINTAIN ALL EROSION CONTROL MEASURES WILL RESULT IN ALL CONSTRUCTION BEING STOPPED ON THE JOB SITE UNTIL SUCH MEASURES ARE CORRECTED BACK TO FULTON COUNTY STANDARDS.
- ALL CONSTRUCTION SHALL CONFORM TO FULTON COUNTY STANDARDS AND SPECIFICATIONS.
- A COPY OF THE APPROVED LAND DISTURBANCE PLAN AND PERMIT SHALL BE PRESENT ON THE SITE WHENEVER LAND DISTURBANCE ACTIVITY IS IN PROGRESS.
- ALL SEWER EASEMENTS DISTURBED MUST BE DRESSED AND GRASSED TO CONTROL EROSION.
- ALL OPEN SWALES MUST BE GRASSED, AND RIP-RIP MUST BE PLACED AS REQUIRED TO CONTROL EROSION. A MINIMUM OF 4.5 SQUARE YARDS OF 50 LB STONES SHALL BE PLACED AT ALL DOWNSTREAM HEADWALLS, PLACED IMMEDIATELY UPON THE INSTALLATION PIPES AND DRAINAGE DITCHES.
- SILT BARRIERS TO BE PLACED AT DOWNSTREAM TOW OF ALL CUT AND FILL SLOPES.
- ANY DISTURBED AREA LEFT EXPOSED FOR A PERIOD GREATER THAN 14 DAYS SHALL BE STABILIZED WITH TEMPORARY SEEDING.
- WHEN ANY CONSTRUCTION BORDERS A DRAINAGE COURSE:
  - THE CONTRACTOR IS RESPONSIBLE FOR REMOVING ANY BUILDING OR OTHER EXCAVATION SPOILED DIRT, CONSTRUCTION TRASH OR DEBRIS, ETC. FROM THE DRAINAGE AREAS SHOWN HEREIN IN AN EXPEDITIOUS MANNER AS CONSTRUCTION PROGRESSES.
  - THE CONTRACTOR HEREBY AGREES TO STOP ALL WORK AND RESTORE THOSE AREAS IMMEDIATELY UPON NOTIFICATION BY THE FULTON COUNTY INSPECTOR AND/OR THE PROFESSIONAL ENGINEER.
  - UPON COMPLETION OF RESTORATION, A PROFESSIONAL ENGINEER SHALL CERTIFY IN WRITING TO THE DEVELOPMENT SERVICES DEPARTMENT THAT ALL CLEAN-UP IS COMPLETE AND THE DRAINAGE COURSE RESTORED TO ORIGINAL CONDITION AND GRADE.
- PROVIDE EROSION CONTROL AND POLLUTION PREVENTION PLAN. INCLUDE NOI INFORMATION, MONITORING POINT(S) AND SPILL PREVENTION PLAN.

**PRIME ENGINEERING INCORPORATED**  
1885 EMERY STREET, N.W., SUITE 300  
ATLANTA, GEORGIA 30318  
404-425-7100

**PROJECT:** MID BROADWELL PETITION SEWER  
**PREPARED FOR:** FULTON COUNTY DEPARTMENT OF PUBLIC WORKS

NO.	DATE	DESCRIPTION
0	03/07/07	CONSTRUCTION DOCUMENTS

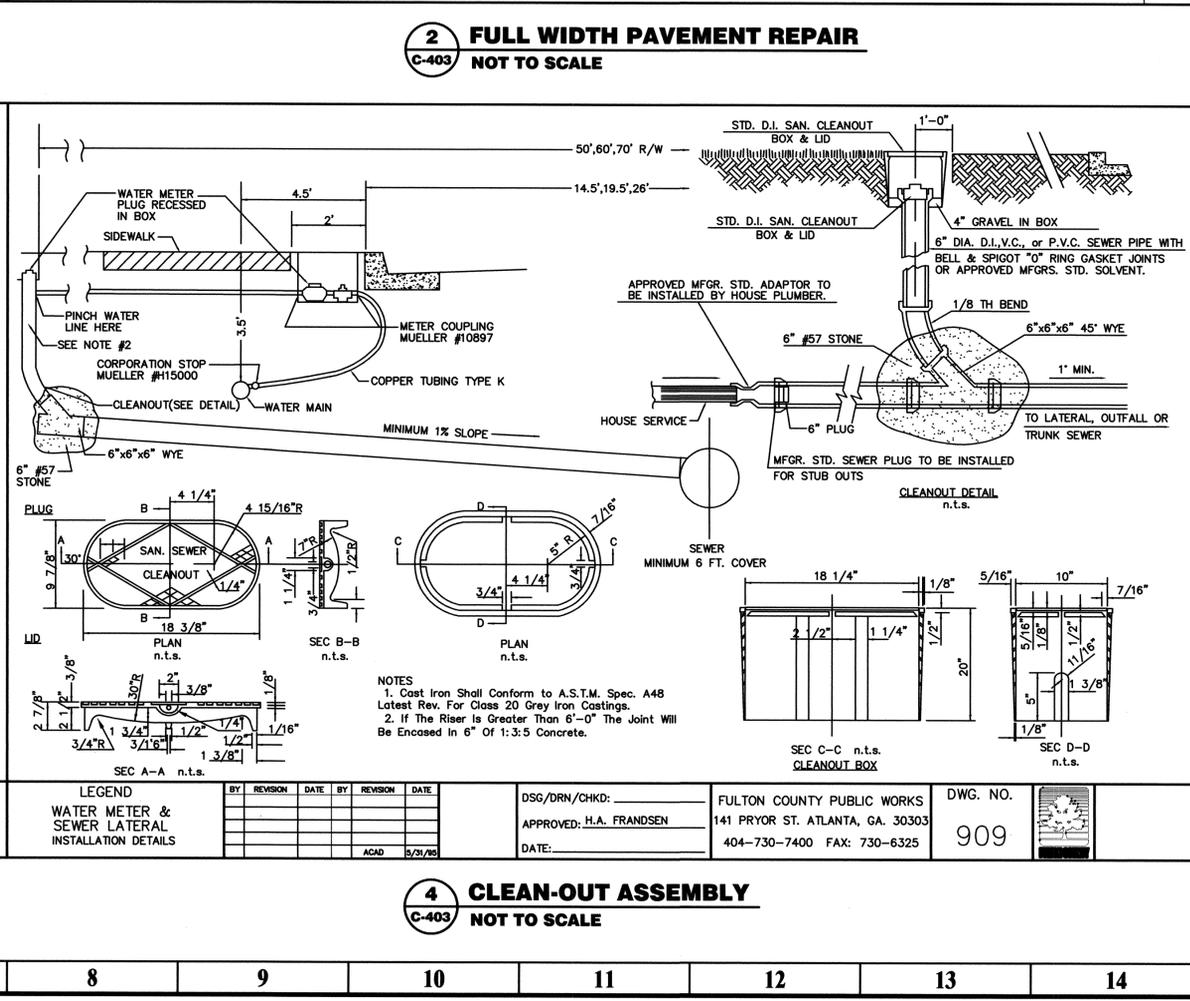
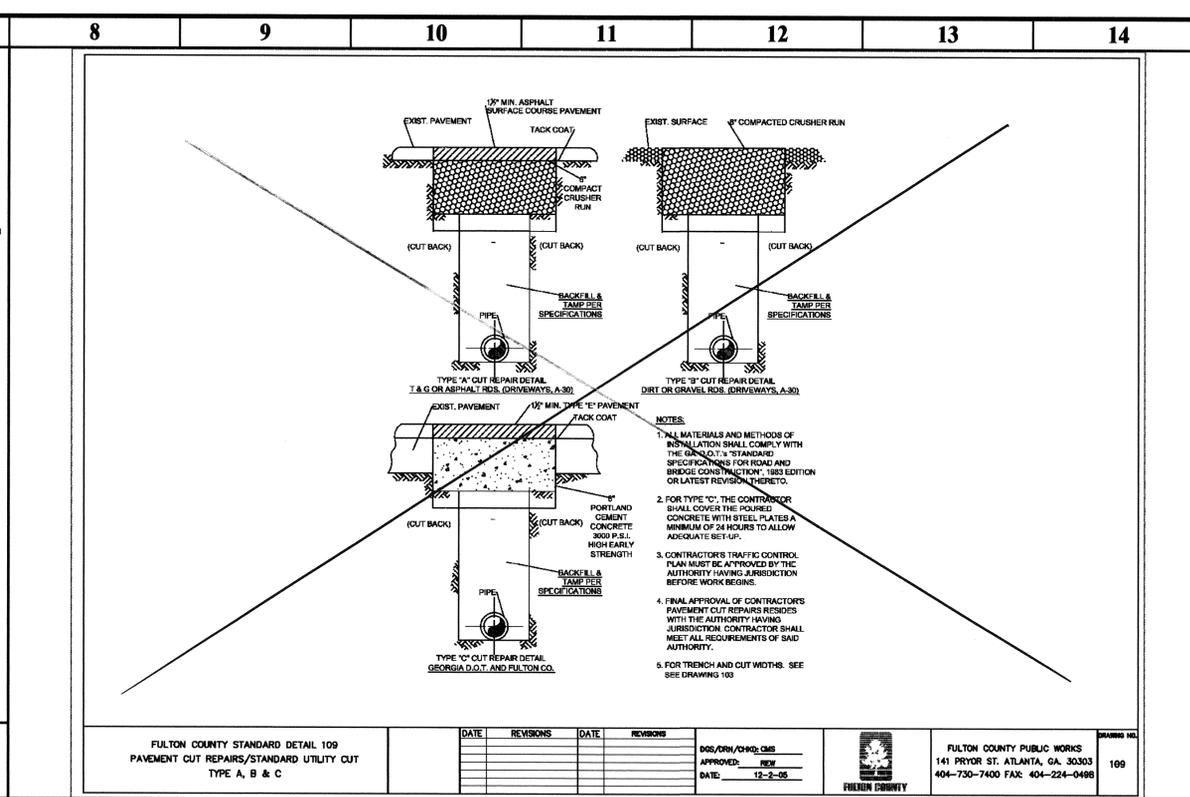
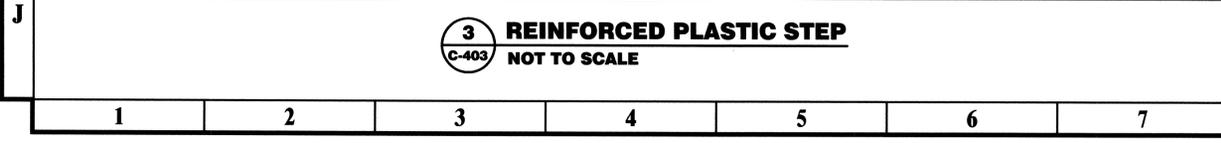
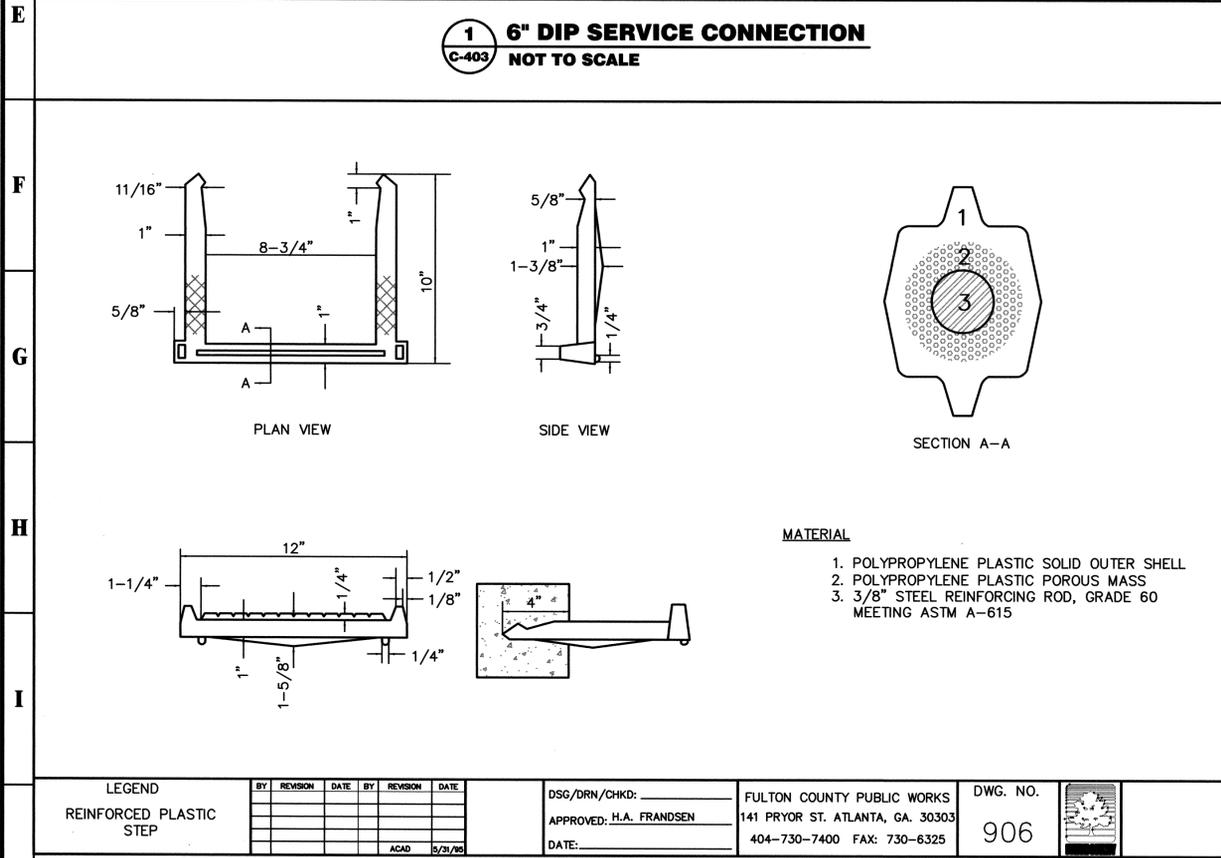
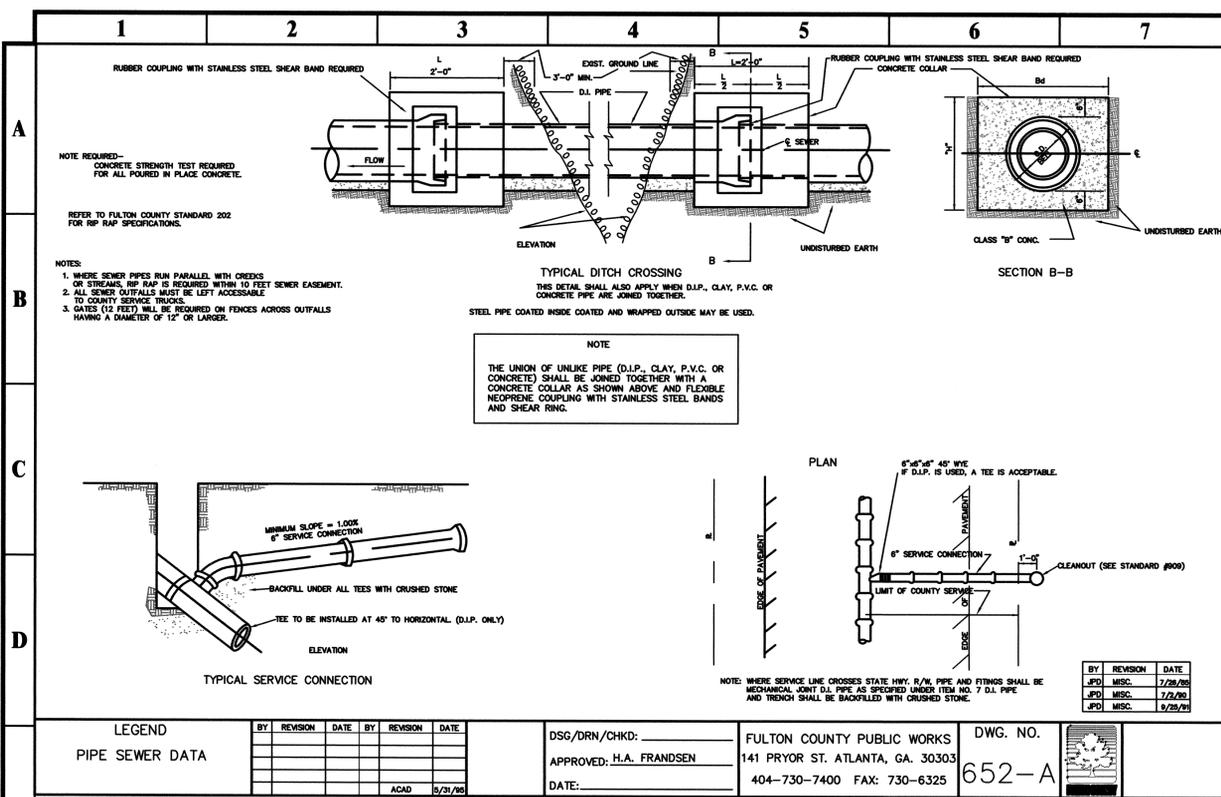
**SEAL:** GEORGIA PROFESSIONAL ENGINEER ANDREW JOHN M. DATE: 03/05/2007

**DRAWING TITLE:** ES&PC DETAILS

<b>DRAWING DATE:</b> 03/07/2007	<b>DRAWN BY:</b> JLS
<b>DRAWING SCALE:</b> NOT TO SCALE	<b>DESIGNED BY:</b> AJS
<b>PROJECT NUMBER:</b> 06-2015-009	<b>CHECKED BY:</b> RRM
<b>DRAWING NUMBER:</b> C-401	<b>NOT ISSUED FOR CONSTRUCTION</b>

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**PRIME ENGINEERING INCORPORATED**  
1885 EMERY STREET, S.W., SUITE 300  
ATLANTA, GEORGIA 30318  
404-425-7100

**PROJECT:**  
MID BROADWELL PETITION SEWER  
PREPARED FOR:  
FULTON COUNTY DEPARTMENT OF PUBLIC WORKS

NO.	DATE	DESCRIPTION
0	05/07/07	CONSTRUCTION DOCUMENTS

**SEAL**  
GEORGIA PROFESSIONAL ENGINEERING BOARD  
No. PE 10000  
\* ANDREW W. JOHNSON  
03/05/2007  
DATE: \_\_\_\_\_

**DRAWING TITLE**  
CONSTRUCTION DETAILS

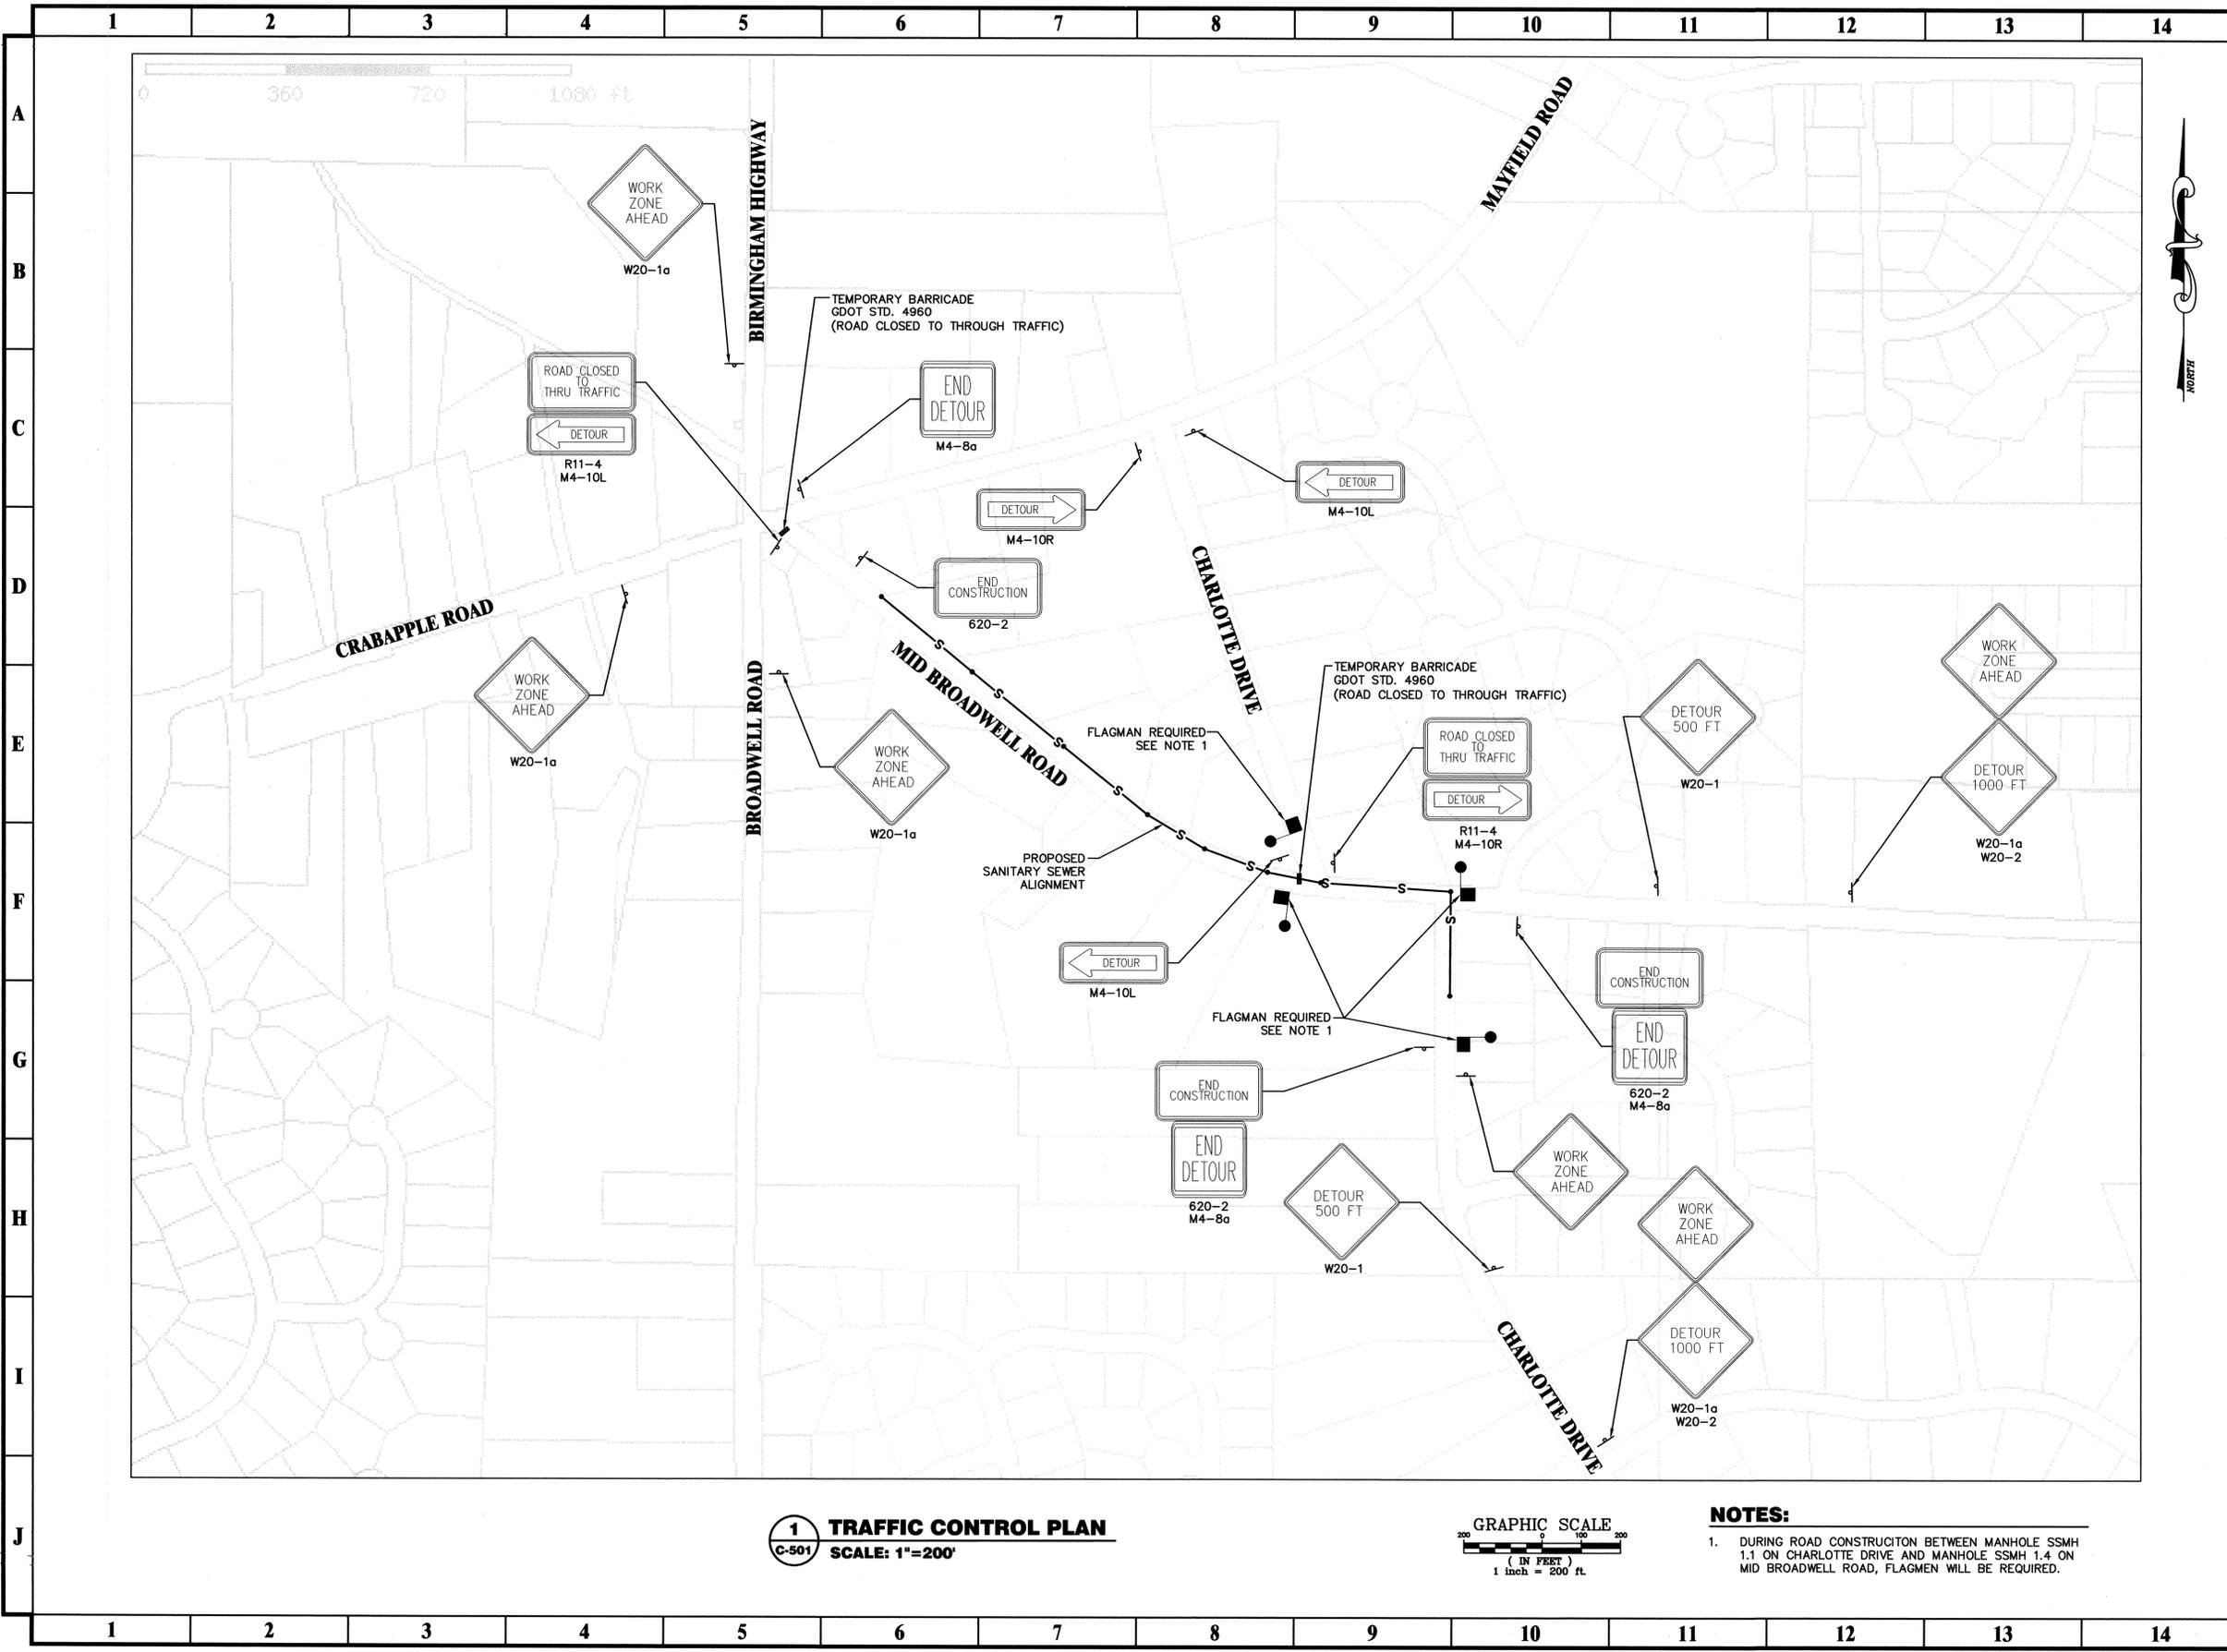
DRAWING DATE	DRAWING SCALE	PROJECT NUMBER	DRAWING NUMBER
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**DRAWN BY:** JLS  
**DESIGNED BY:** AJS  
**CHECKED BY:** RRM

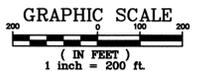
**NOT ISSUED FOR CONSTRUCTION**

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**1** TRAFFIC CONTROL PLAN  
 C-501 SCALE: 1"=200'



- NOTES:**
- DURING ROAD CONSTRUCTION BETWEEN MANHOLE SSMH 1.1 ON CHARLOTTE DRIVE AND MANHOLE SSMH 1.4 ON MID BROADWELL ROAD, FLAGMEN WILL BE REQUIRED.

<b>PRIME ENGINEERING INCORPORATED</b>							
888 EMERY STREET, NW, SUITE 300 ATLANTA, GEORGIA 30318 404-423-7100							
<b>PROJECT:</b> MID BROADWELL PETITION SEWER <b>PREPARED FOR:</b> FULTON COUNTY DEPARTMENT OF PUBLIC WORKS							
<b>REVISIONS</b>	<b>SEAL</b>						
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NO.	DATE	DESCRIPTION					
0	03/07/07	CONSTRUCTION DOCUMENTS					
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<b>TRAFFIC CONTROL PLAN</b>							
<b>DRAWING DATE</b> 03/07/2007 <b>DRAWING SCALE</b> 1" = 200' <b>PROJECT NUMBER</b> 06-2015-009 <b>DRAWING NUMBER</b> C-501	<b>DRAWN BY</b> JLS <b>DESIGNED BY</b> AJS <b>CHECKED BY</b> RRM	<b>NOT ISSUED FOR CONSTRUCTION</b>					